FRAME ANCHOR REQUIREMENTS TABLE			
OPENING TYPE (SUBSTRATE)	FRAME/CLIP/BRICKMOLD/HINGE TO OPENING FASTENER TYPE	MINIMUM EMBED	MINIMUM EDGE DIST.
BRICKMOLD (SIDES & HEAD)			
MIN. 2X4 WOOD FRAME OR BUCK (MIN. GR. 3 & G=0.55)	NO. 6 X 1 1/2" SMS (FLAT HEAD)	1 3/8"	1/2"
MIN. 2X4 WOOD FRAME OR BUCK (MIN. GR. 3 & G=0.55)	10D GALV. FINISH NAILS	1 3/8"	1/2"
INSTALLATION CLIP			
MIN. 2X4 WOOD FRAME OR BUCK (MIN. GR. 3 & G=0.55)	NO. 8 X 1 1/2" SMS	1 3/8"	1/2"
SILL SHEAR SCREWS			
MIN. 2X4 WOOD FRAME OR BUCK (MIN. GR. 3 & G=0.55)	NO. 10 SMS OR WOOD SCREW	1 1/4"	3/4"
MIN. 2500 PSI CONCRETE	(1) 3/16" CONCRETE SCREW	1 1/4"	2"
HEAD/JAMB SHEAR SCREWS			
MIN. 2X4 WOOD FRAME OR BUCK (MIN. GR. 3 & G=0.55)	NO. 10 SMS OR WOOD SCREW	1 1/4"	3/4"
(1) CONCRETE SCREWS SHALL BE ELCO OR ITW RAMSET/RED HEAD TAPCONS, HILTI			

GENERAL NOTES

- 1. BUCKING, OPENINGS & BUCKING FASTENERS MUST BE PROPERLY DESIGNED & INSTALLED TO TRANSFER WIND LOADS TO THE STRUCTURE.
- 2. ALL ANCHORS SHALL BE IN ACCORDANCE WITH THESE DRAWINGS & MAY NOT VARY UNLESS SPECIFICALLY MENTIONED ON THE DRAWINGS.

KWIK-CON II OR POWERS RAWL TAPPER (HARDENED STEEL OR S.S.).

- 3. THESE DOOR SYSTEM INSTALLATIONS HAVE BEEN DESIGNED IN ACCORDANCE WITH & MEET THE REQUIREMENTS OF THE 2004 FLORIDA BUILDING CODE (F.B.C.) FOR NON-HVHZ (NON-HIGH VELOCITY HURRICANE ZONES).


 4. THESE DOOR SYSTEMS ARE NON-IMPACT RATED & MUST BE SHUTTERED WHERE REQUIRED BY CODE.
- 5. ALL DOOR SIZES SPECIFIED ARE AS CONTROLLED BY THE TESTED UNITS.
- 6. TO THE BEST OF OUR KNOWLEDGE, THE DOORS SHOWN HEREIN ARE CERTIFIED AND/OR QUALITY ASSURED BY A FLORIDA STATE APPROVED CERTIFICATION/QA ENTITY & SHALL BE LABELED IN ACCORDANCE WITH THE STATE CODE & CHAPTER 98-72 DEPARTMENT OF COMMUNITY AFFAIRS-FLORIDA BUILDING COMMISSION SPECIFICATIONS. BY LABELING THE WINDOW, THE MANUFACTURER CONFIRMS THAT THE PRODUCT IS ASSEMBLED IN ACCORDANCE WITH THEIR RESPECTIVE QA & TESTING REPORTS.
- 7. ALL FRAME ANCHORS SECURING DOOR FRAME TO PRESSURE TREATED BUCKS OR WOOD FRAMING SHALL BE CAPABLE OF RESISTING CORROSION CAUSED BY THE PRESSURE TREATING CHEMICALS IN THE WOOD.

 8. ALL ANCHORS SHALL BE INSTALLED AS SPECIFIED ON THESE DRAWINGS. SPECIFIED EMBEDMENT TO BASE MATERIAL SHALL BE BEYOND WALL FINISH OR STUCCO.
- 9. THIS DRAWING CERTIFIES INSTALLATION ONLY (NOT MANUFACTURING OR WEATHER PROOFING OF THE DOOR).

 CERTIFICATION OF THESE DOOR INSTALLATIONS SHALL BE CONSIDERED VOID IF ANY OF THE FOLLOWING APPLY:

 1. IF THESE DOORS ARE INSTALLED BY ANYONE OTHER THAN A LICENSED CONTRACTOR EXPERIENCED WITH DOOR
- 2. IF THE DOORS ARE INSTALLED WITHOUT A PERMIT FROM THE APPLICABLE LOCAL BUILDING DEPARTMENT.

 3. IF THE DOOR INSTALLATION IS NOT INSPECTED EITHER BY THE APPLICABLE LOCAL BUILDING DEPARTMENT INSPECTOR
- OR ANOTHER PROFESSIONAL LICENSED TO PERFORM INSPECTIONS. O. THESE INSTALLATIONS ARE BASED ON TESTING & RATIONAL ANALYSIS. TEST REPORTS CONSIDERED WITH THIS CERTIFICATION ARE REPORT NO. 2005-386-8915REV BY STORK TWIN CITY TESTING CORP.

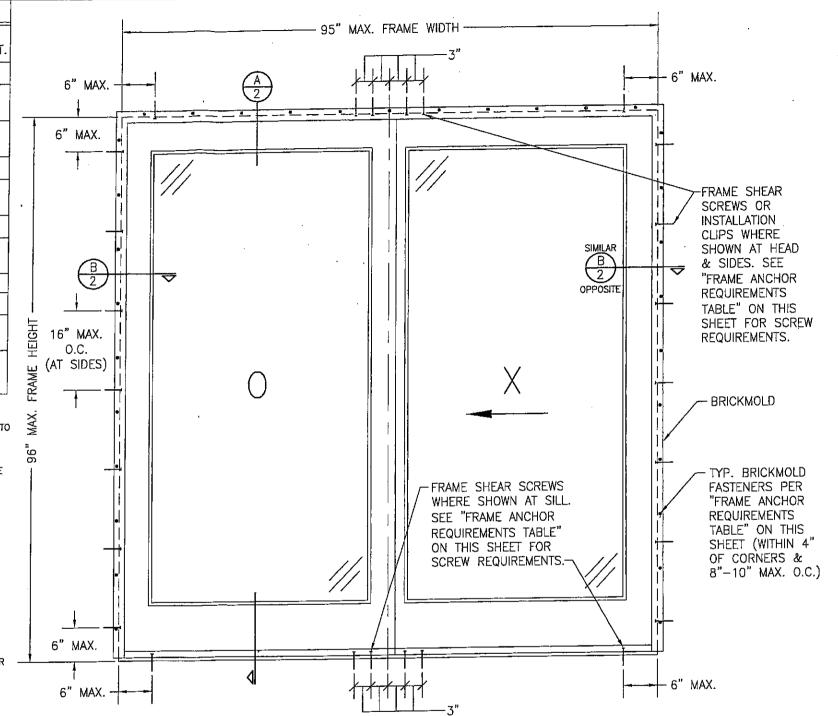

CHECKED BY: W.W.S.

DATE: 10/12/07

WINDSOR WINDOWS & DOORS 900 S. 19TH STREET WEST DES MOINES, IA 50265 800-218-6186

DOOR

SLIDING

NON-IMPACT

吊吊

OCT

1559 SHEET NO. OF

CHAEFER ENGINEERING CONSULTING, P.A.

ORAWN EY:

. 1⇔16


EXTERIOR ELEVATION; 2 PANEL SLIDING DOOR

SCALE: 3/4"=1'-0"

ALLOWABLE DESIGN PRESSURE

+/-40 PSF

NOTE: PRESSURES APPLY TO INSTALLATION ONLY & NOT DOOR ASSEMBLY CONDITIONS

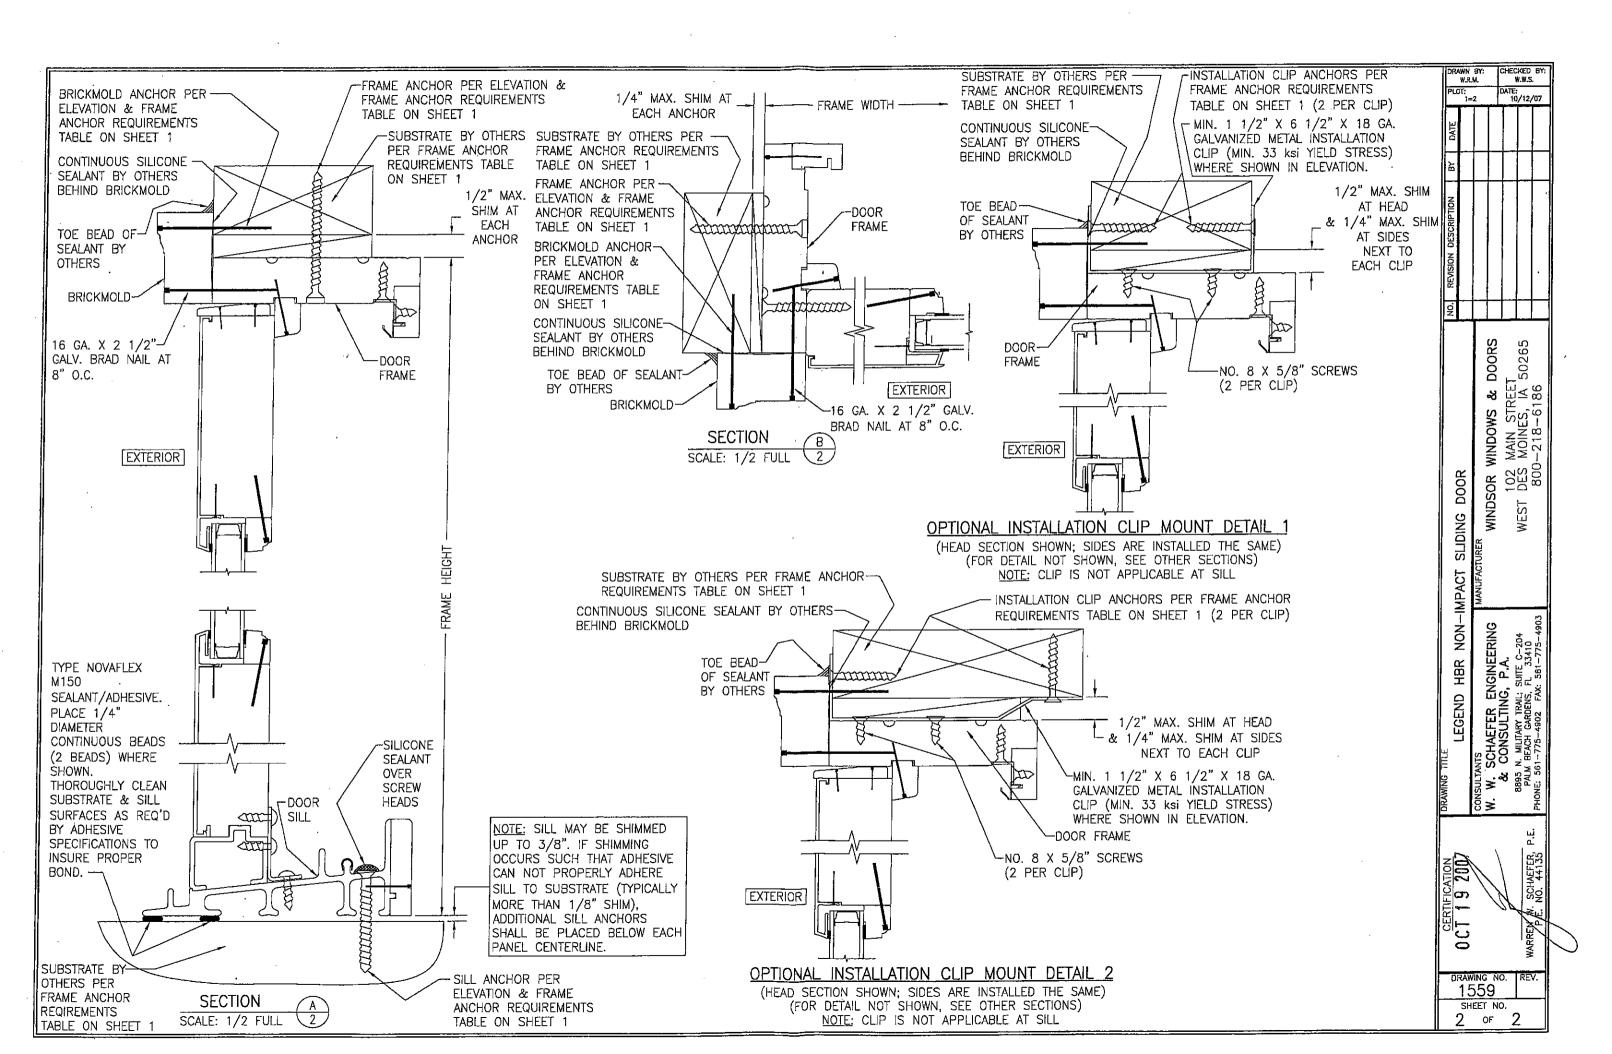

CBUCK Engineering

Specialty Structural Engineering

CBUCK, Inc. Florida Certificate of Authorization #8064

Validation

of
Installation Instructions
for
Windsor Windows & Doors
Windsor Series
"Legend HBR Sliding Door"

Florida Product Approval # FL 10085.1

In compliance with Florida Building Code 2004

Prepared for:
Windsor Windows & Doors
900 S. 19th Street
West Des Moines, IA 50265

Prepared by:

James L. Buckner, P.E.

Florida Professional Engineer # 31242 Florida Validation ANE ID: 1916 Report No. 07-303-2-VR Date: 12/20/07

Contents:

Validation Report

Pages 1-2

James L. Buckner, P.E. Florida P.F. # 31242

Torida P.E. # 31242

CBUCK, Inc.

1334 S. Killian Drive, Suite 4, West Palm Beach, Florida 33403 Phone: (561)491-9927 Fax: (561)491-9928 Website: www.cbuckinc.net

FL #: Date:

FL 10085.1

12/20/07 Report No.: 07-303-2-VR

Page

2 of 2

CBUCK Engineering

Specialty Structural Engineering

CBUCK, Inc. Florida Certificate of Authorization # 8064

Manufacturer:

Windsor Windows & Doors

Product Name:

"Legend HBR Sliding Door"

Reviewed

Installation Instructions:

Drawings by Warren W. Schaefer, P.E. (Florida P.E. #44135)

1. Drawing No. 1559, Sheets 1-2, Signed & Sealed 10/19/07

Installation Instructions

Engineer:

Warren W. Schaefer, P.E. (Florida P.E. #44135)

Technical Validation Statement:

A review of the above referenced installation instructions and supporting data including test reports, anchor calculations, alternate supporting substrates and referenced technical documents demonstrate results equivalent or superior with the tested samples. The additional anchors have been verified to comply with acceptable standards of engineering principles and demonstrate compliance with Florida Building Code, 2004 with Supplements.

Validation Compliance:

The installation instructions comply with the technical validation requirements of Rule 9B-72.080(2)(c).

Document Filing:

A copy of this validation report, above referenced installation drawings and all supporting data will be filed with CBUCK Engineering as long as this validation is effective.

Reference Documents:

1. AAMA Test Report (FBC Organization #CER ID:1498)

By Stork Twin City Testing Corp.

Report #: 2005-386-8915.rev, Report Date: 1/17/06